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GENERAL NOTES

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FETHARD BALLROOM REFURBISHMENT for FETHARD & KILLUSTY COMMUNITY BALLROOM COMPANY LTD.

DRAWING: GROUND FLOOR PLAN -

SCALE: 1/50

DRAWN: MB

CHECKED: KH FIRST ISSUE:


05/07/2019


DRAWING NUMBER:

1817(TD)03

STATUS: TENDER DRAWING

01/07/2019

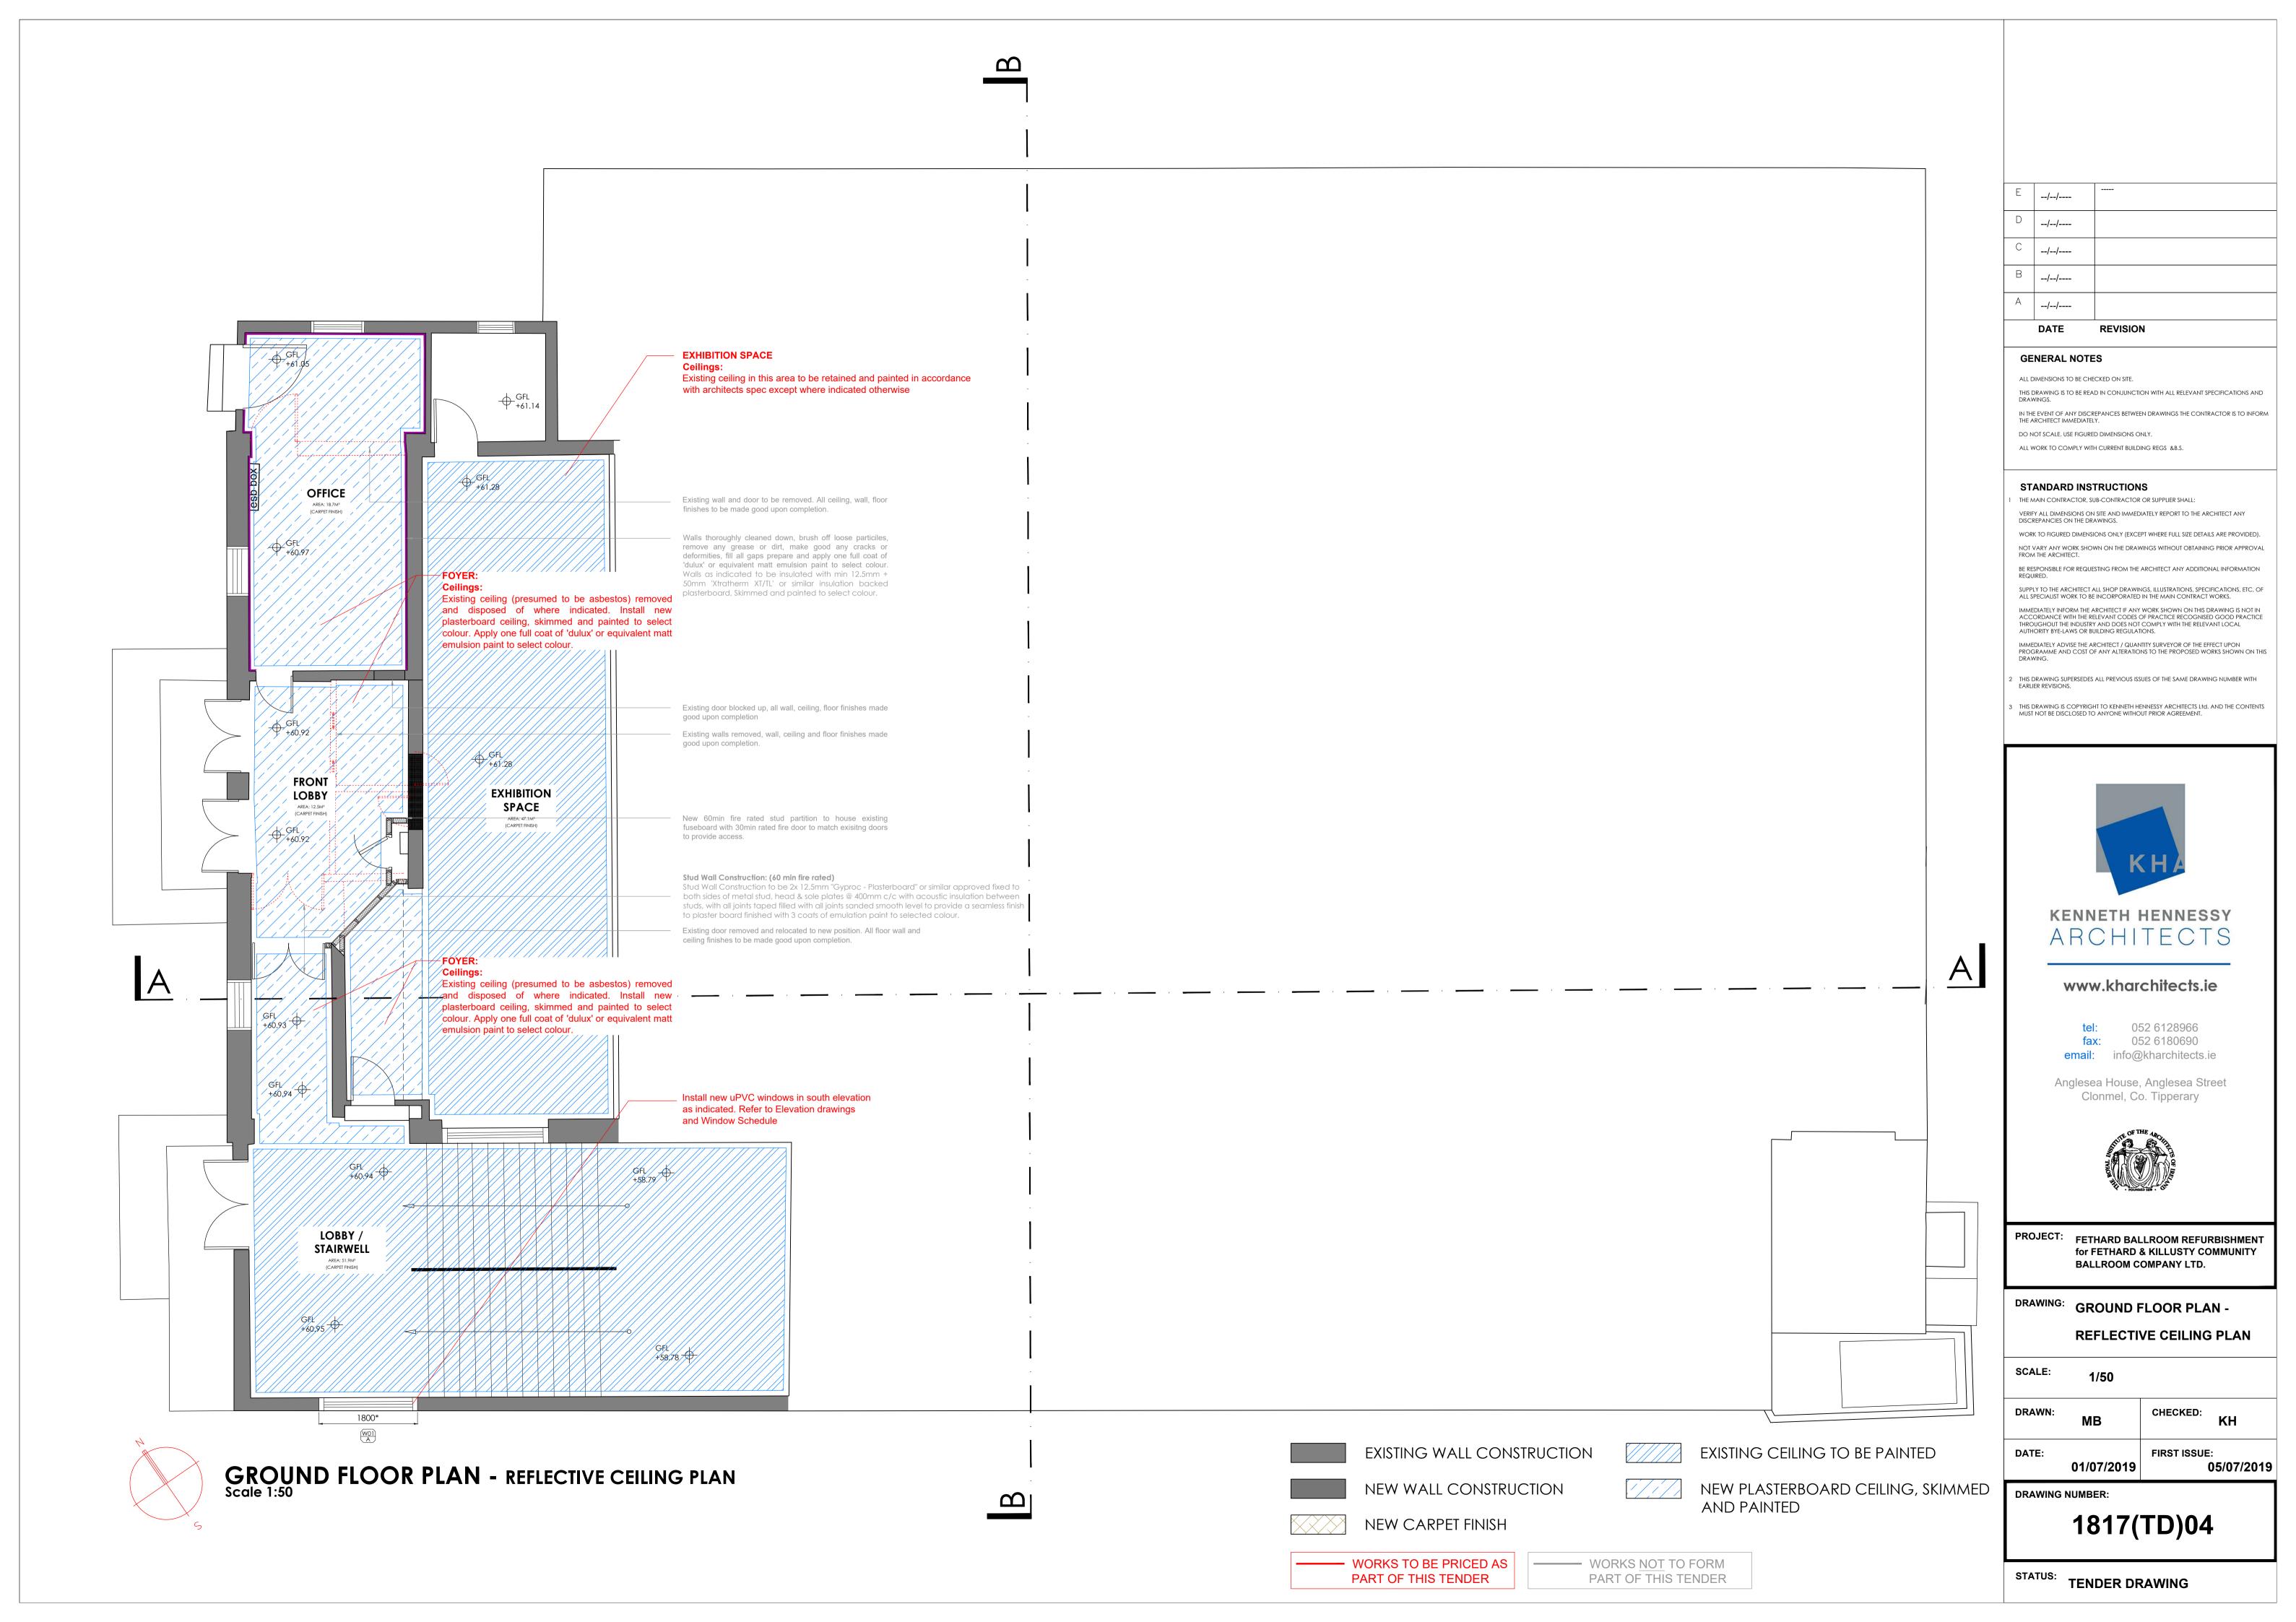

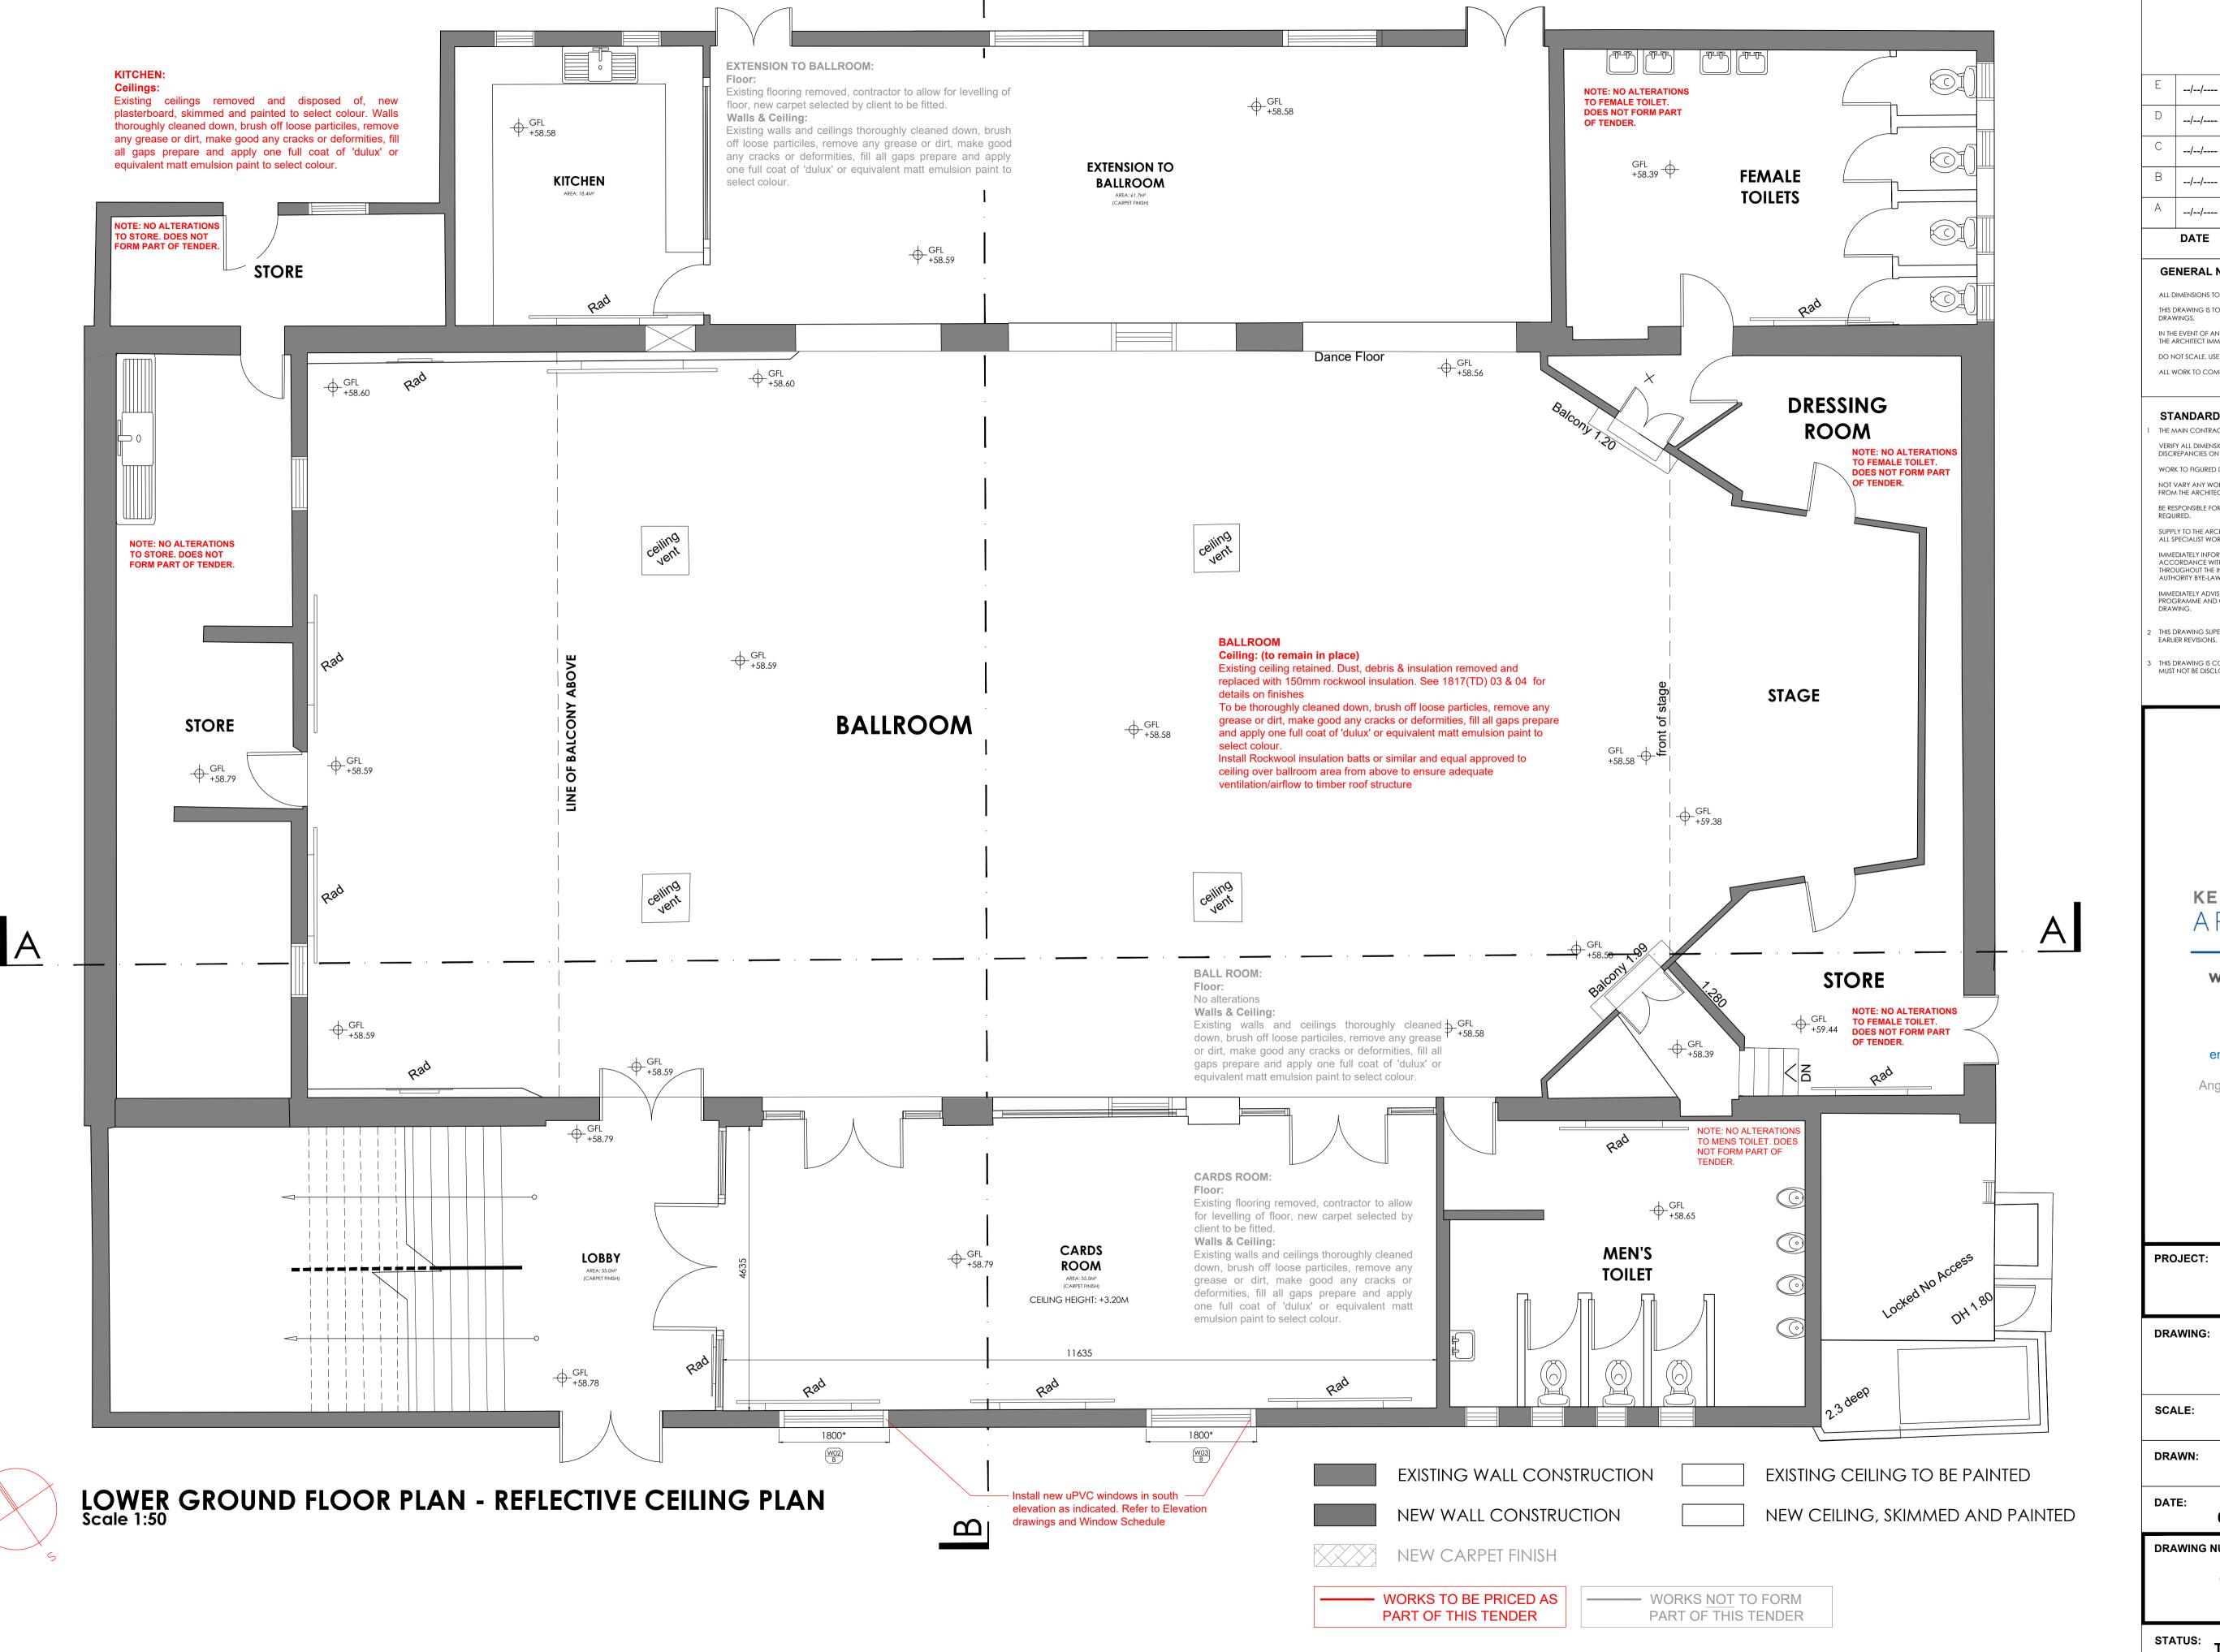

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immediately advise the architect / Quantity surveyor of the effect upon programme and cost of any alterations to the proposed works shown on this

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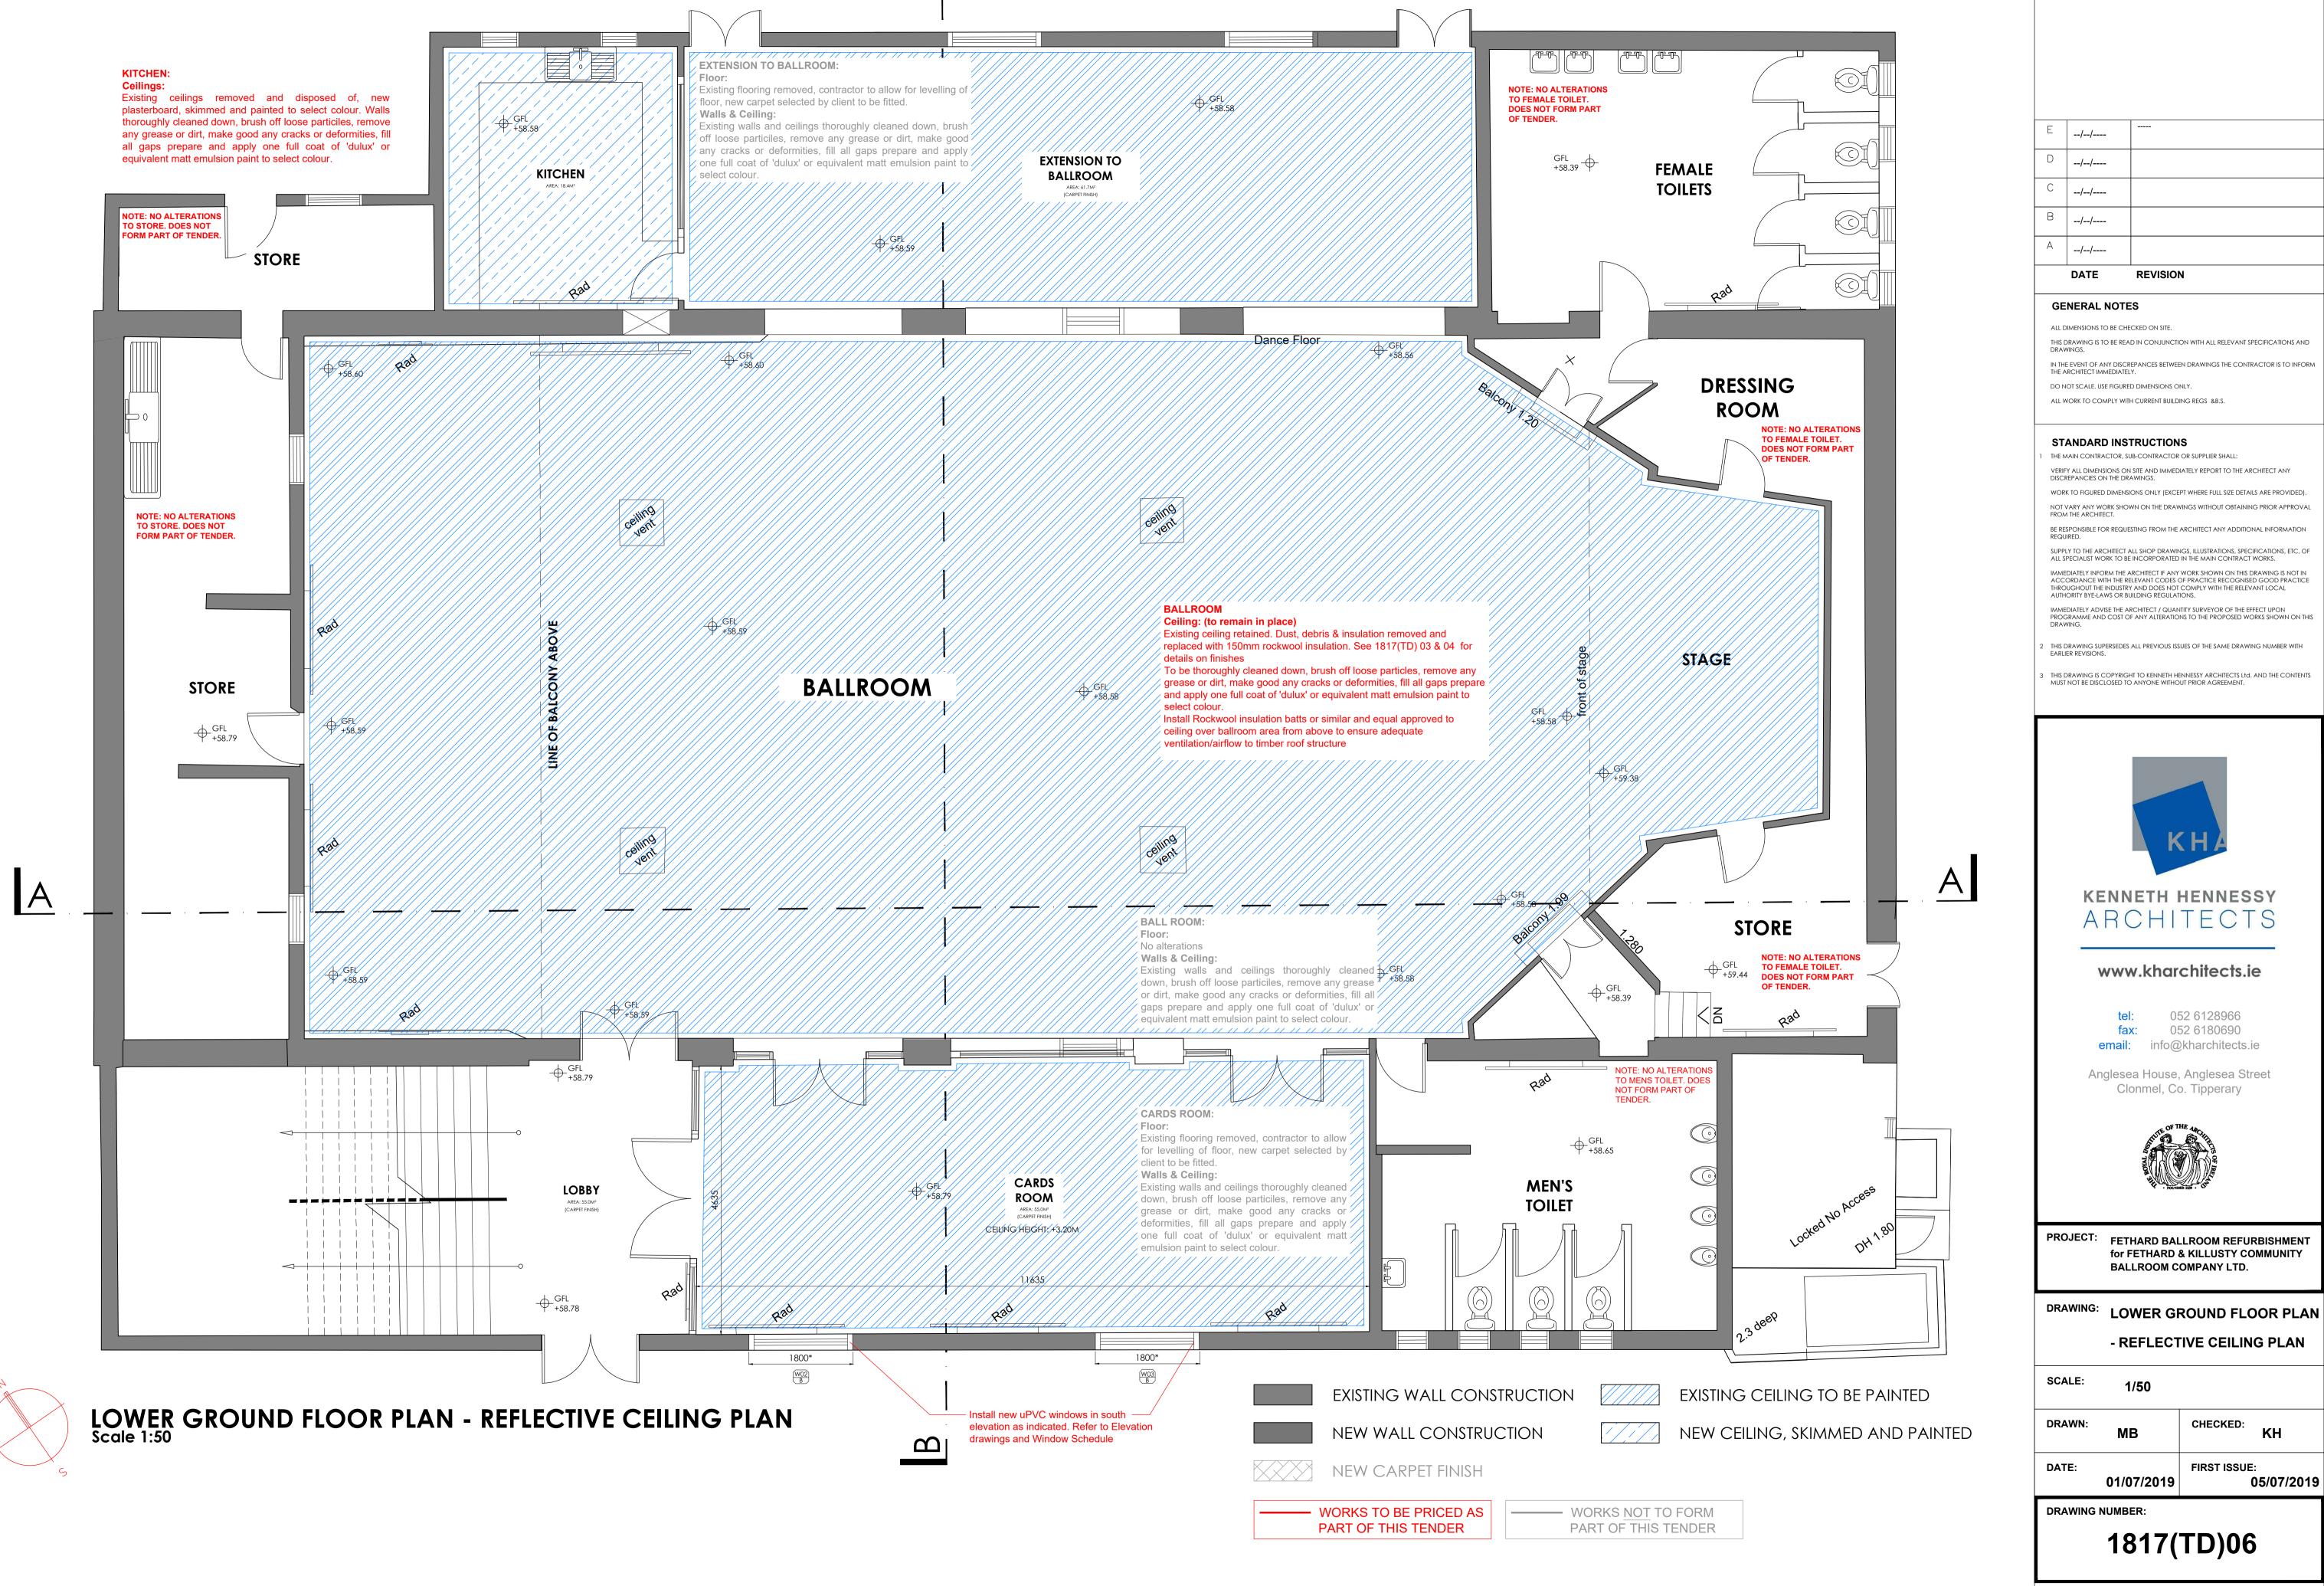
DRAWING: LOWER GROUND FLOOR PLAN

1/50 CHECKED: MB

KH 05/07/2019 01/07/2019

DRAWING NUMBER:

1817(TD)05



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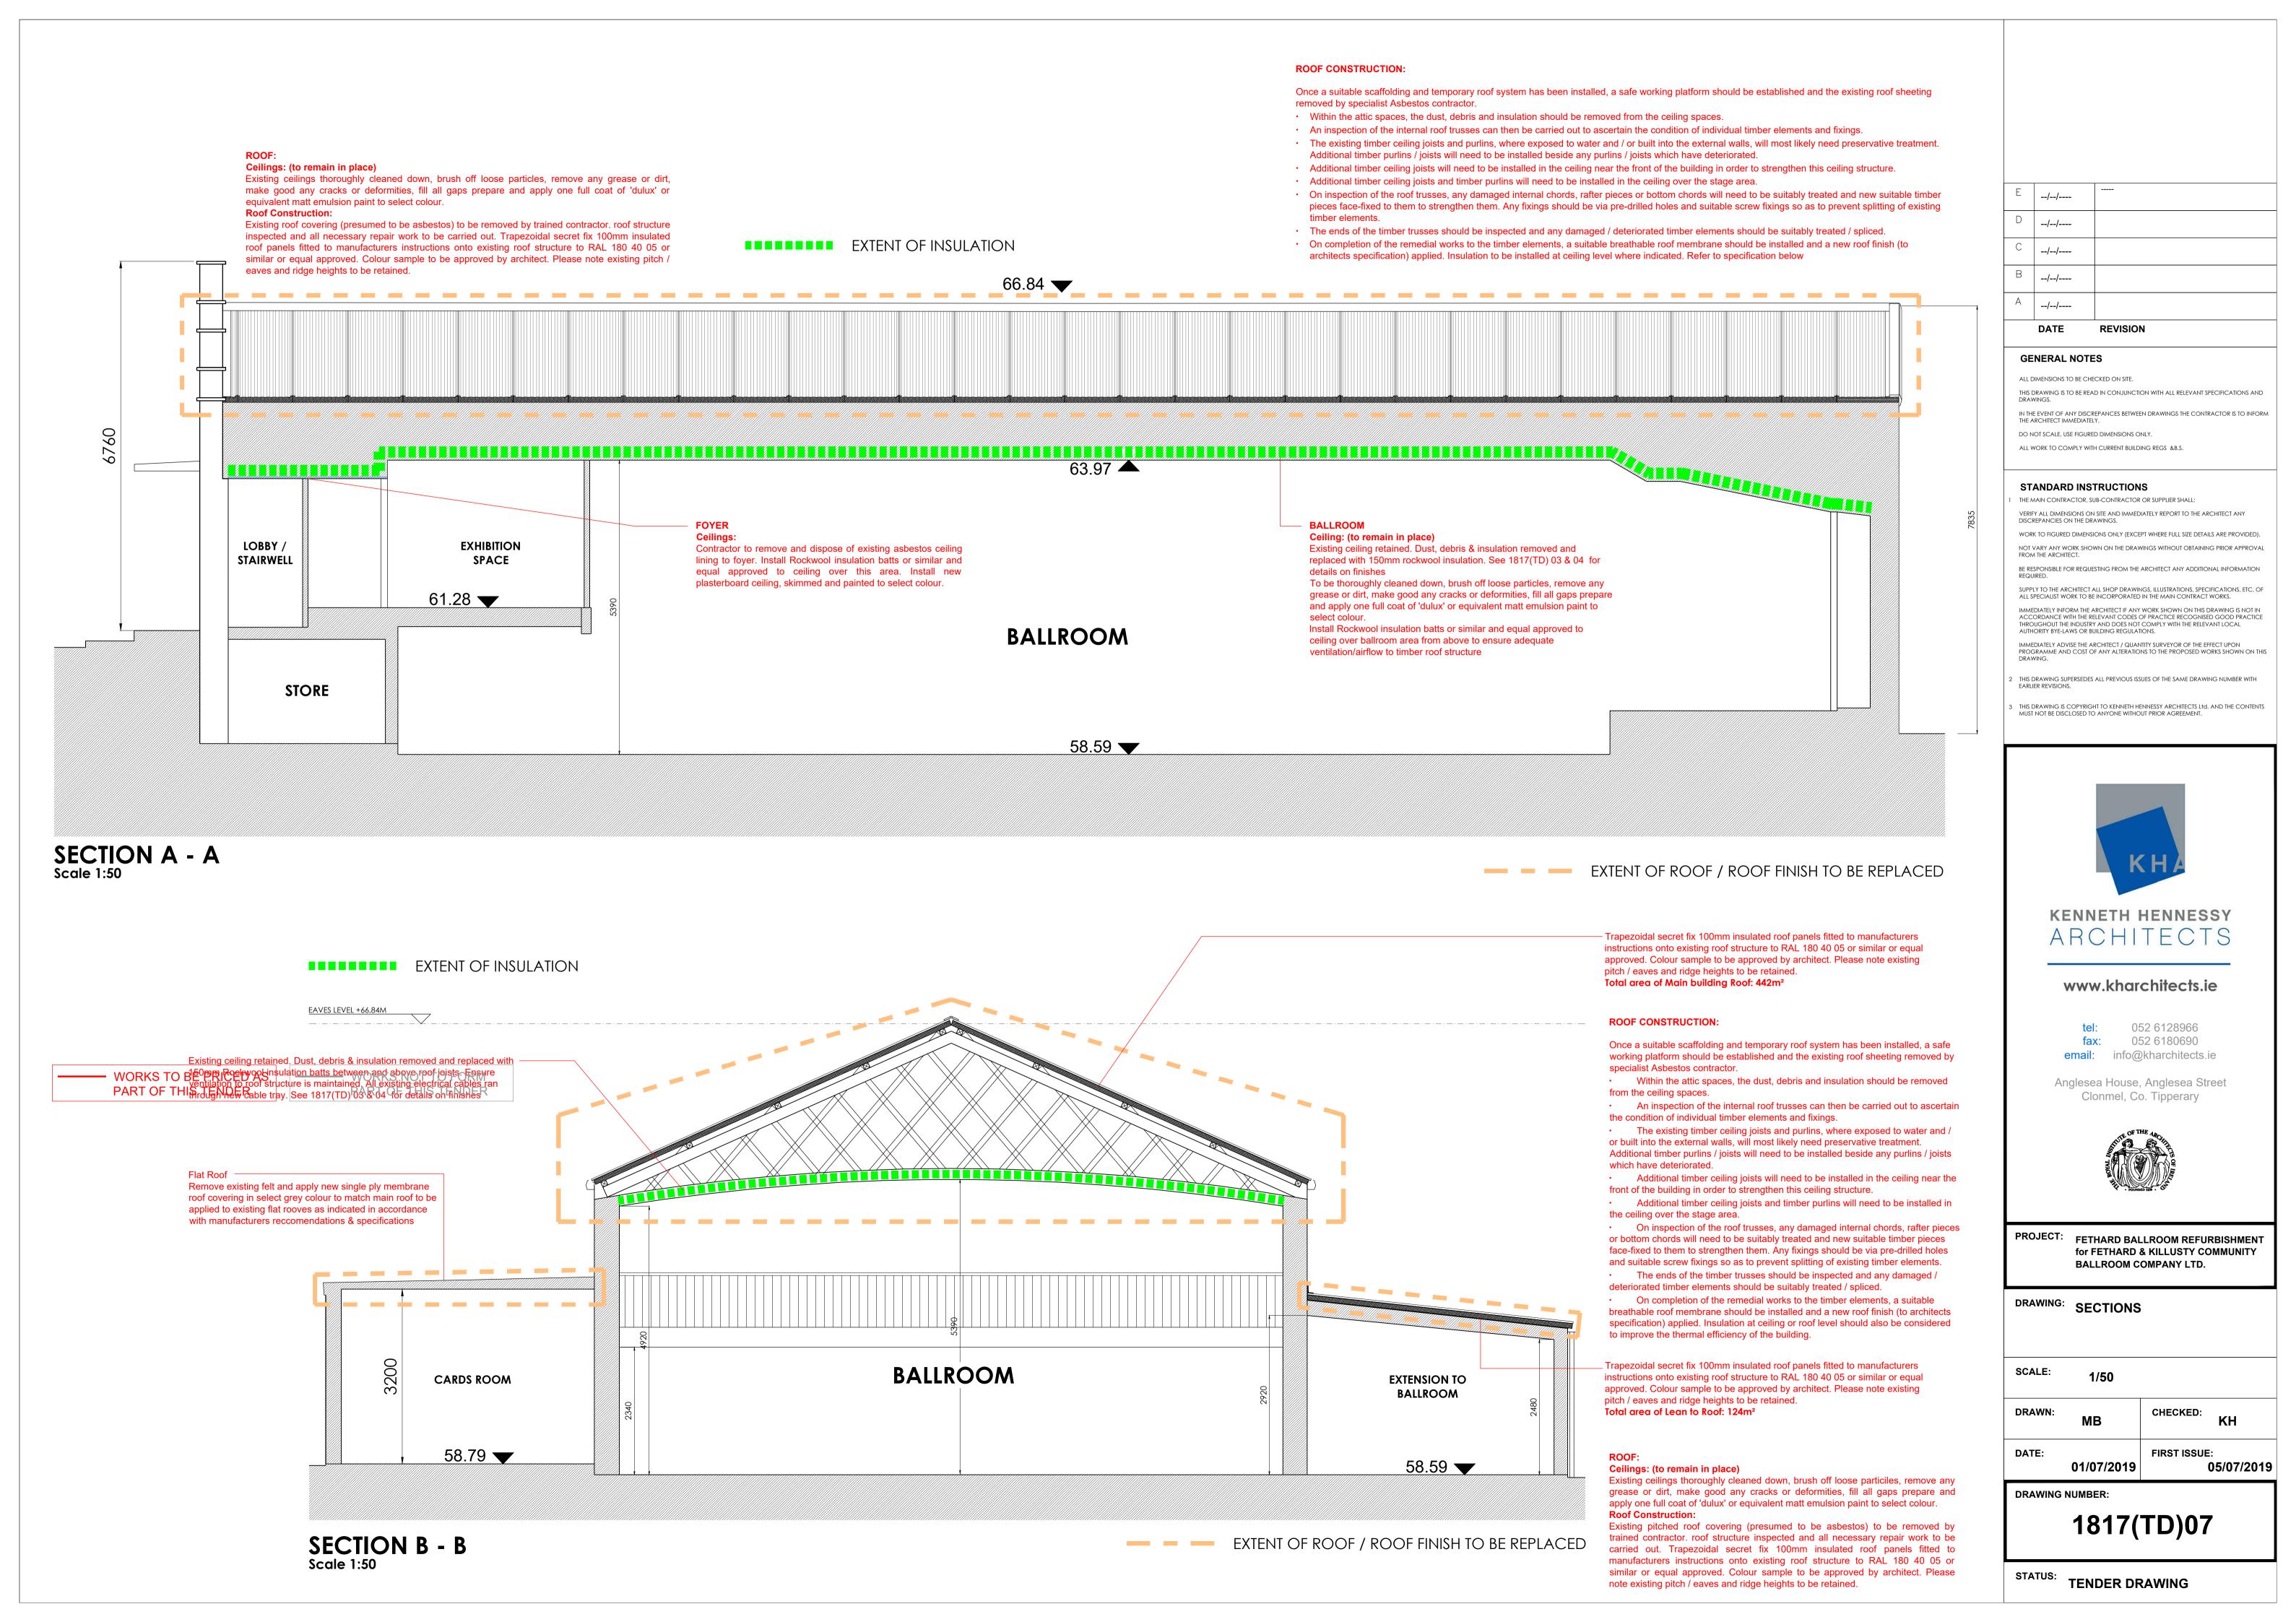
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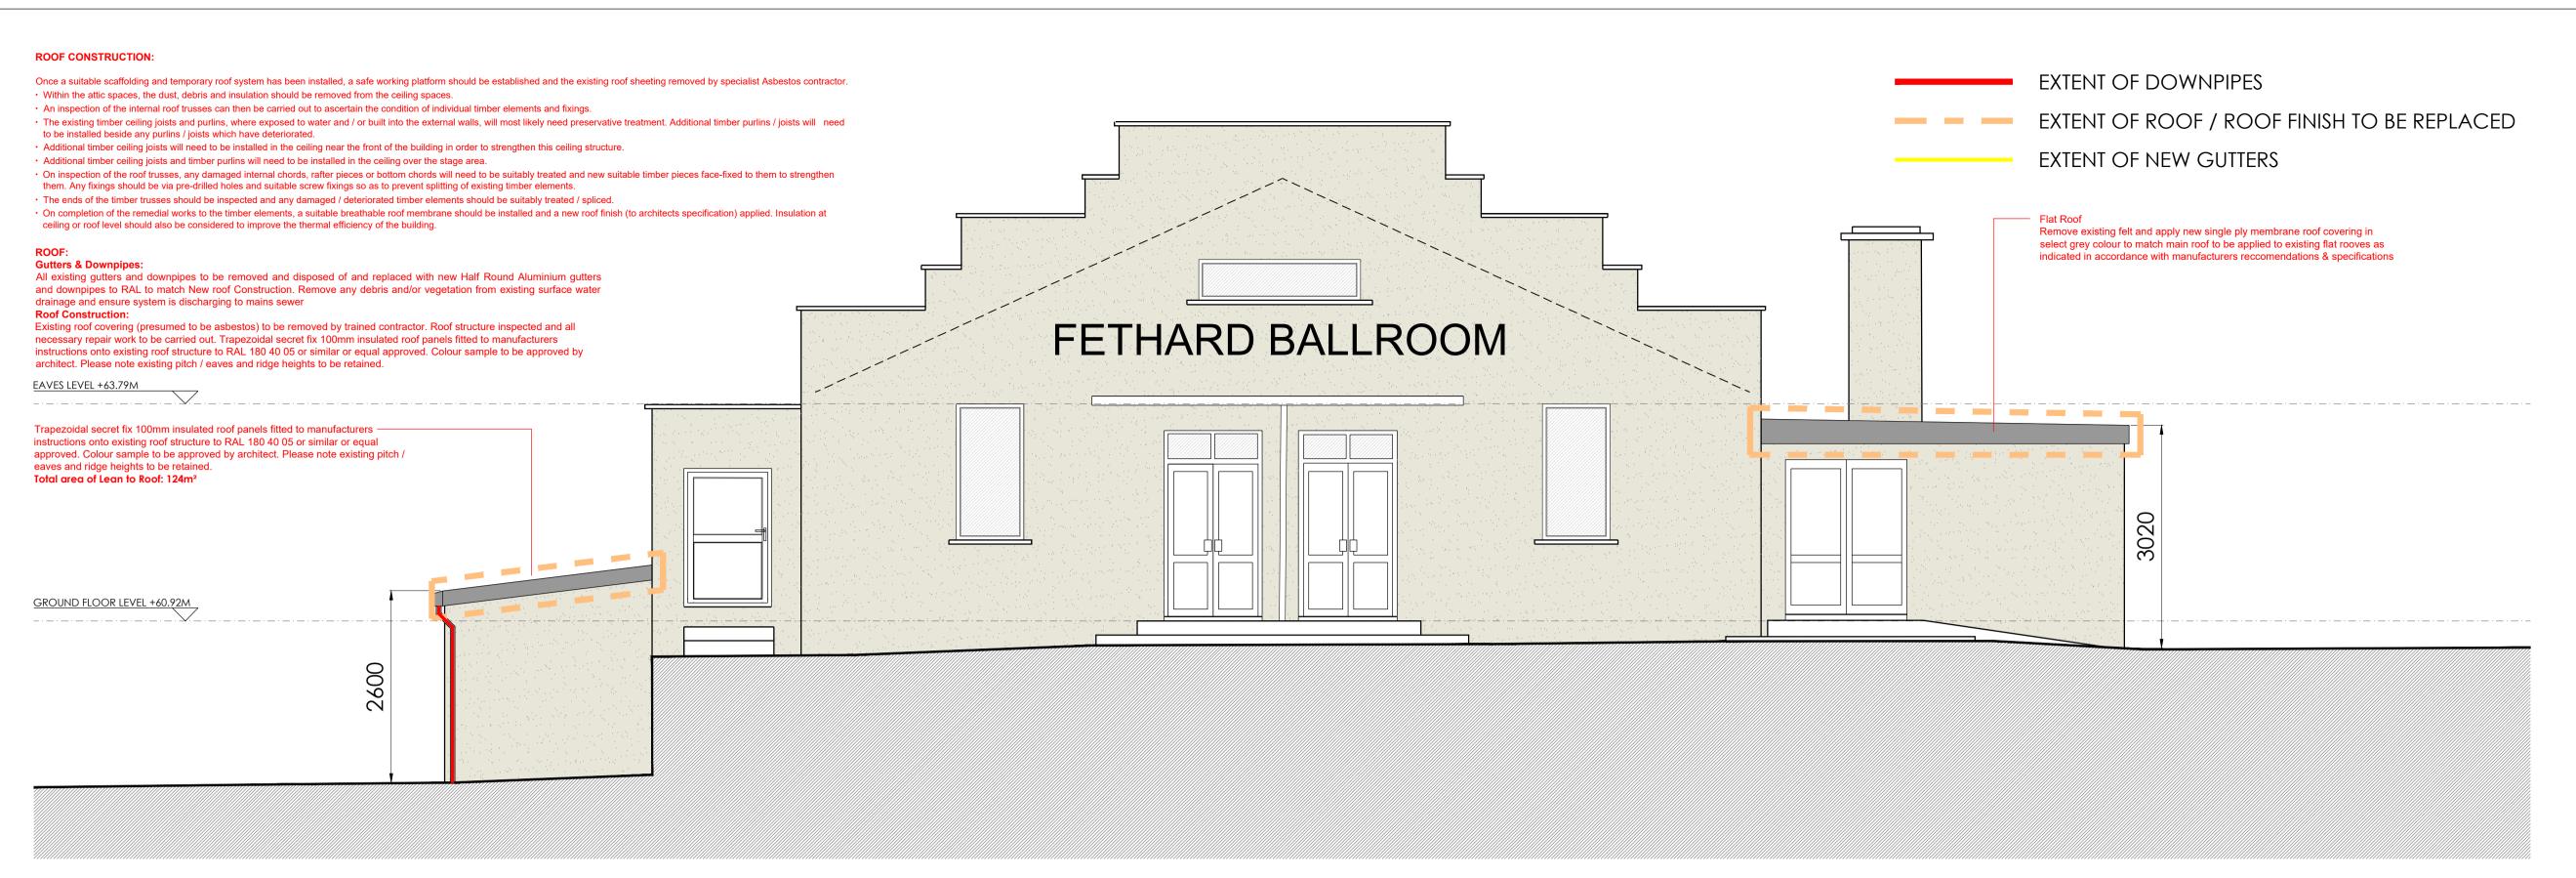
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for FETHARD & KILLUSTY COMMUNITY

- REFLECTIVE CEILING PLAN

KH FIRST ISSUE:





WEST ELEVATION - FRONT

Once a suitable scaffolding and temporary roof system has been installed, a safe working platform should be established and the existing roof sheeting • Within the attic spaces, the dust, debris and insulation should be removed from the ceiling spaces. EXTENT OF DOWNPIPES An inspection of the internal roof trusses can then be carried out to ascertain the condition of individual timber elements and fixings. The existing timber ceiling joists and purlins, where exposed to water and / or built into the external walls, will most likely need preservative treatment. Additional timber purlins / joists will need to be installed beside any purlins / joists which have deteriorated. — EXTENT OF ROOF / ROOF FINISH TO BE REPLACED Additional timber ceiling joists will need to be installed in the ceiling near the front of the building in order to strengthen this ceiling structure. Additional timber ceiling joists and timber purlins will need to be installed in the ceiling over the stage area. On inspection of the roof trusses, any damaged internal chords, rafter pieces or bottom chords will need to be suitable EXTENT OF NEW GUTTERS timber pieces face-fixed to them to strengthen them. Any fixings should be via pre-drilled holes and suitable screw fixings so as to prevent splitting of The ends of the timber trusses should be inspected and any damaged / deteriorated timber elements should be suitably treated / spliced. On completion of the remedial works to the timber elements, a suitable breathable roof membrane should be installed and a new roof finish (to architects specification) applied. Insulation at ceiling or roof level should also be considered to improve the thermal efficiency of the building. Existing asbestos cement sheeting to be replaced with corrugated metal sheeting roof to select dark Gutters & Downpipes: grey colour; existing roof pitch and ridge heights to All existing gutters and downpipes to be removed and disposed of and replaced with new Half Round Aluminium gutters and downpipes to RAL to match New roof Construction. Remove any be maintained debris and/or vegetation from existing surface water drainage and ensure system is discharging to mains sewer **Roof Construction:** Existing roof covering (presumed to be asbestos) to be removed by trained contractor. Roof structure inspected and all necessary repair work to be carried out. Trapezoidal secret fix 100mm insulated roof panels fitted to manufacturers instructions onto existing roof structure to RAL 180 40 05 or similar or equal approved. Colour sample to be approved by architect. Please note existing pitch / eaves and ridge heights to be retained. EAVES LEVEL +63.79M _____ GARAGE FLOOR LEVEL +60.92M

EAST ELEVATION - FRONT Scale 1:50

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PROGRAMME AND COST OF ANY ALTERATIONS TO THE PROPOSED WORKS SHOWN ON THIS DRAWING.

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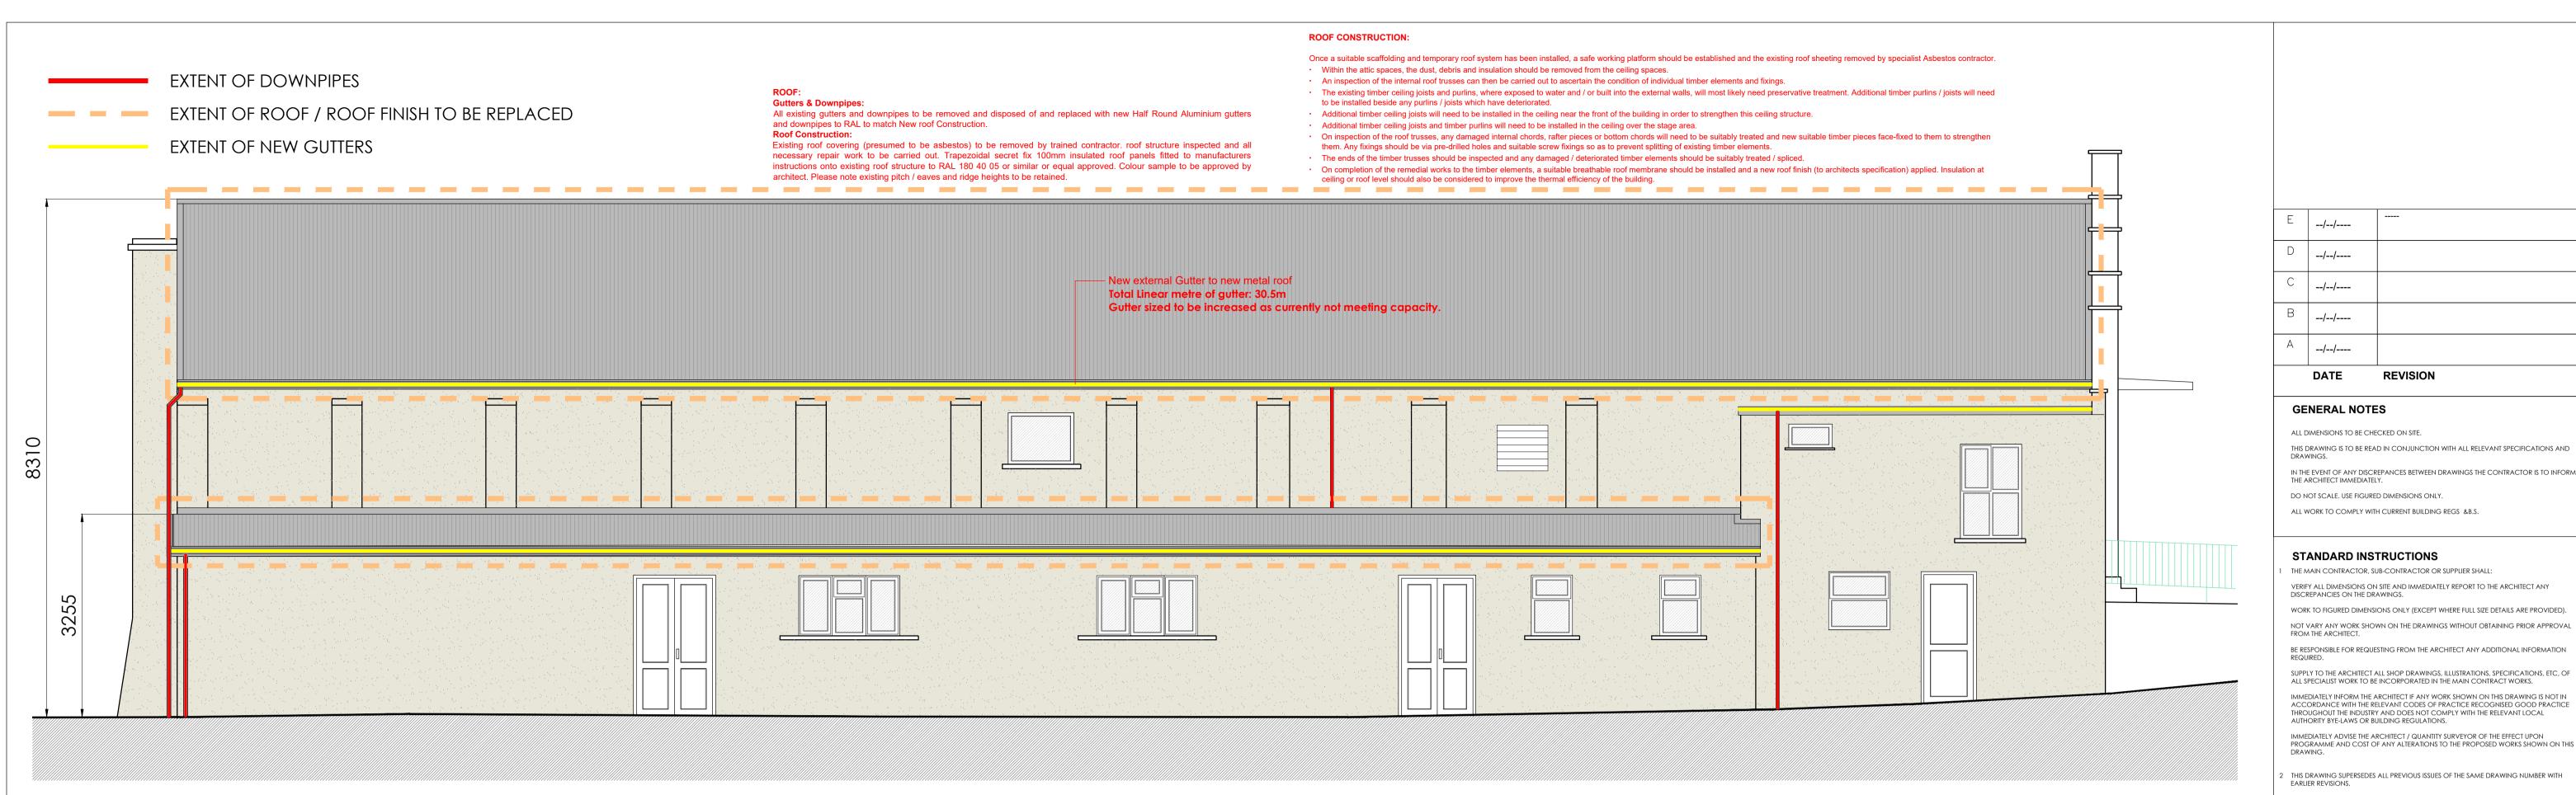
DRAWING: ELEVATIONS

DRAWN: MB CHECKED: KH


DATE: 01/07/2019 FIRST ISSUE: 05/07/2019

DRAWING NUMBER:

1817(TD)08



NORTH ELEVATION - SIDE Scale 1:50

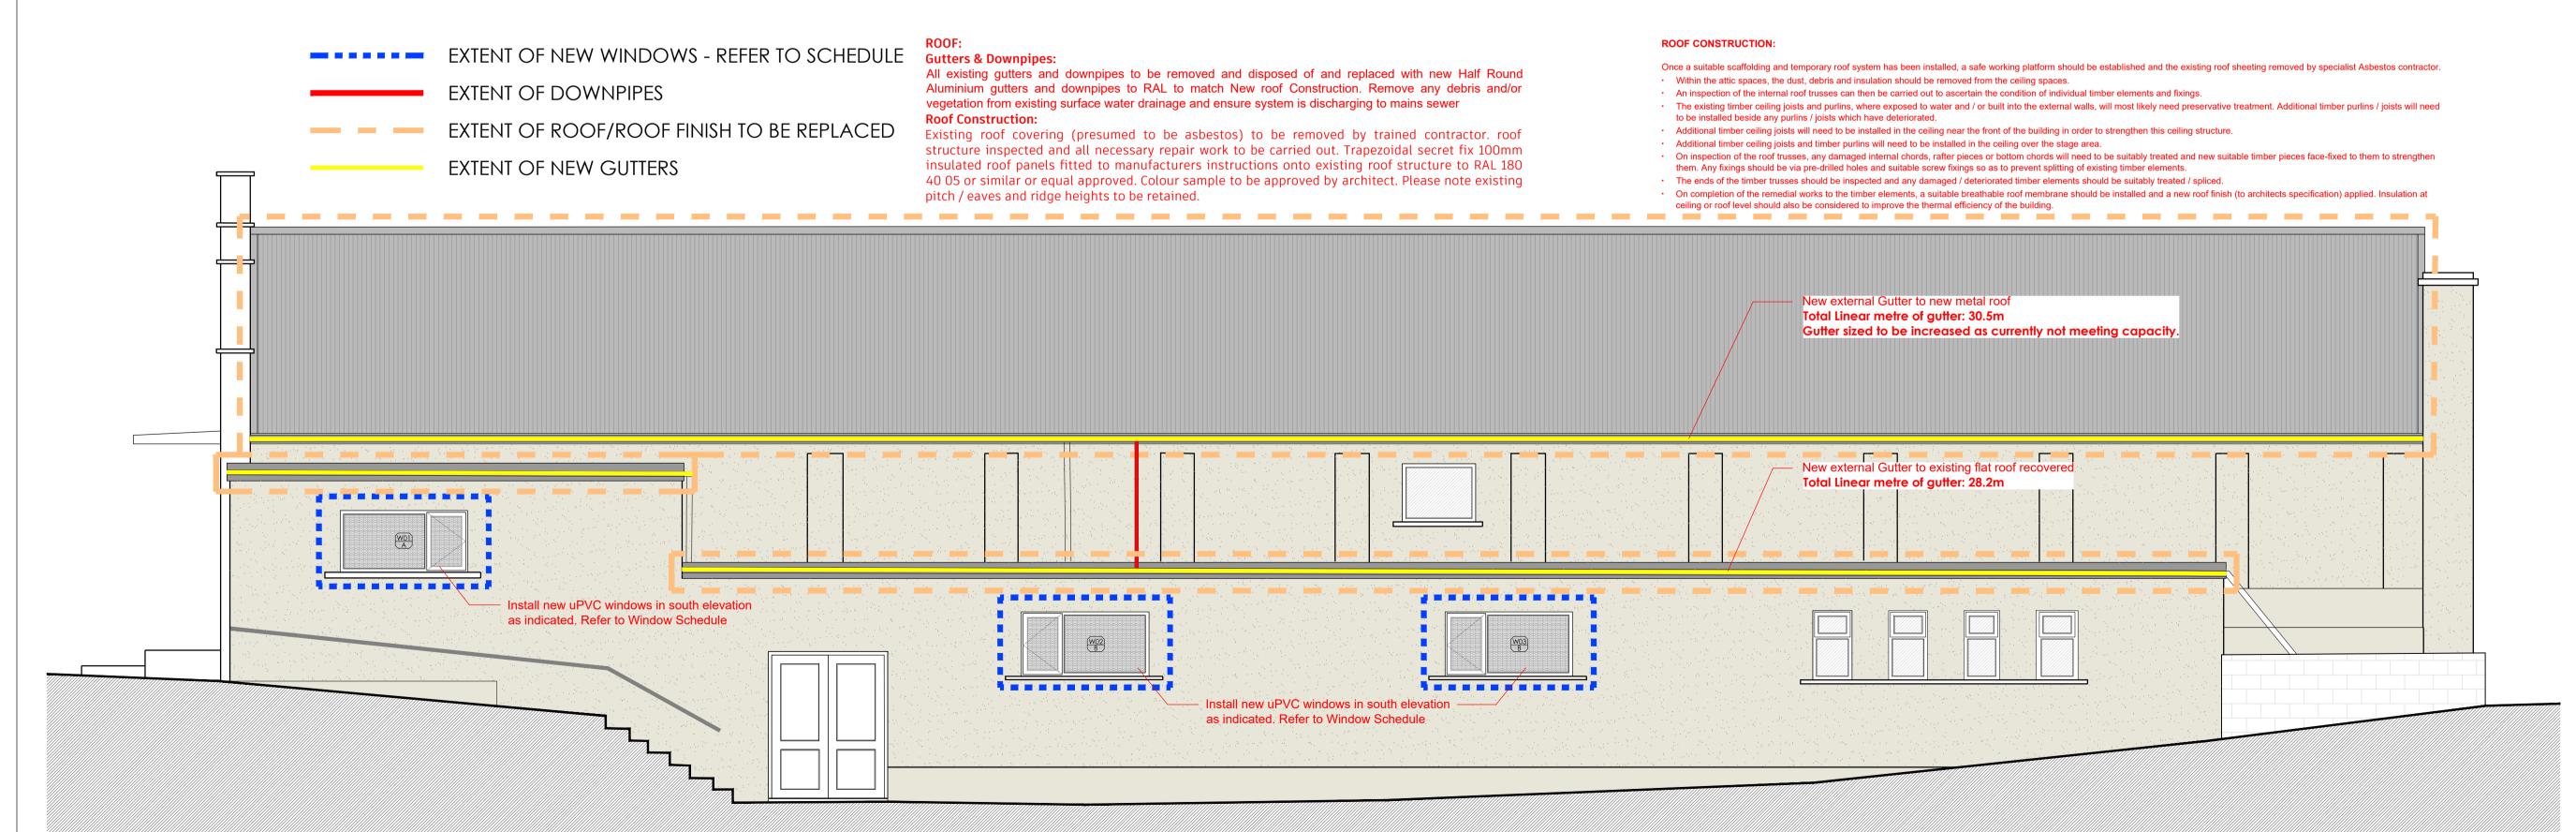

SOUTH ELEVATION - SIDE Scale 1:50

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DRAWING: ELEVATIONS

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SCALE: 1/50 DRAWN: CHECKED: MB

DATE: 01/07/2019


DRAWING NUMBER:

1817(TD)09

KH

05/07/2019

FIRST ISSUE:

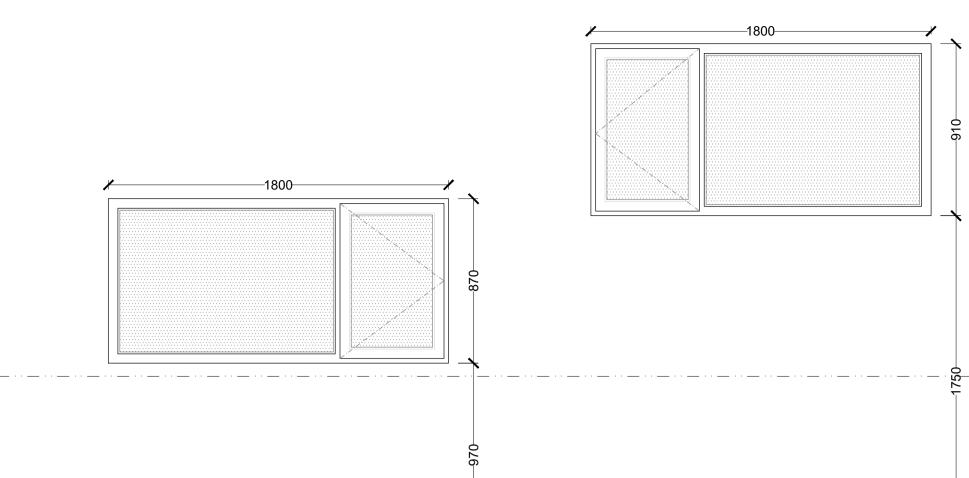

WINDOW TYPE A EXTERNAL

DESCRIPTION: uPVC unit, With 1 no. side hung opening casement and 1 no. fixed unit in selected colour

GLAZING: Low-E, Argon filled Double

safety glazing

TOTAL NO: LOCATION: W01

EXACT DIMENSIONS OF WINDOW OPES TO BE CONFIRMED ON SITE PRIOR TO ORDER BY CONTRACTOR/WINDOW MANUFACTURER

WINDOW TYPE B

EXTERNAL

LOCATION:

DESCRIPTION: uPVC unit, With 1 no. side hung opening casement and 1 no. fixed unit in selected colour

GLAZING: Low-E, Argon filled Double

safety glazing

W02, W03

TOTAL NO:

EXACT DIMENSIONS OF WINDOW OPES TO BE CONFIRMED ON SITE PRIOR TO ORDER BY

CONTRACTOR/WINDOW MANUFACTURER

WINDOWS:

1. Windows to have a U-Value of 1.6 W/m2K or better. 2. All new windows to be Munster Joinery Prestige range or similar approved.3. All new doors, windows and rooflights dimensions to be verified on site by supplier prior to manufacture and installation.

4. All new windows swings to be verified on plans/elevations by contractor prior to manufacture.

5. All bedroom windows to have unlockable ironmongery and appropriate

egress hinges for fire escape windows. 6. All Bathroom, WC and En suite windows to be glazed with Opaque Glass -Internal face of pane in double glazed unit to be sandblasted.

7. All glass below 800mm to be safety glass as required. 8. All new openable windows to have permavent permenent trickle

PROTECTION OF COMPONENTS

vents incorporated into window frame.

Do not deliver to site components which cannot be put immediately into suitable dry, floored and covered storage. Stack on bearers, separated with spacers to prevent damage by and to projecting ironmongery, beads, etc.

PRIMING/SEALING

Before fixing components ensure that surfaces of timber which will be inaccessible after installation are primed or sealed as specified

BUILDING IN

This will not be permitted except where specifically stated on the drawings.

WINDOW INSTALLATION

Install windows into prepared openings, maintaining a maximum gap of 8mm between the frame edge and the surrounding construction. Install windows without twist or diagonal racking.

SEALANT JOINTS

convex profile.

Silicone to be an approved polysulphide with colour to be approved. Prepare joints and apply sealant. Finish triangular fillets with a flat or slightly

IRONMONGERY / ACCESSORIES

Sample to be provided for approval. Assemble and fix carefully and accurately using fasteners with matching finish supplied by ironmongery maunfacturer. Prevent damage to ironmongery and adjacent surfaces. At completion check, adjust and lubricate as necessary to ensure correct functioning.

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DRAWING: WINDOW SCHEDULE

SCALE: 1/20

MB

01/07/2019

CHECKED: KH FIRST ISSUE:

05/07/2019

DRAWING NUMBER:

1817(TD)10